#### **GENERAL NOTES**

- 01. EXISTING CONDITIONS DATA BASED ON DOCUMENT ENTITLED "ZONING LOCATION & TOPOGRAPHIC SURVEY 6 NUTMEG LN. PREPARED FOR DEAN C. HATFIELD & DEBORAH HATFIELD DARIEN, CT" BY WILLIAM SEYMOUR & ASSOCIATES ON SEPTEMBER 23, 2020.
- 02. DEFINITIONS: "AS REQUIRED" MEANS AS REQUIRED TO PRODUCE A FULLY COMPLETED PROJECT. THE WORD "SHALL" MEANS A CONDITION MUST BE FULLY & COMPLETELY MET.
- 03. DRAWINGS, NOTES, & SPECIFICATIONS: SHALL BE STUDIED & UNDERSTOOD PRIOR TO BIDDING OR THE START OF WORK. EXISTING & PROPOSED CONDITIONS SHALL BE FIELD VERIFIED WITH DISCREPANCIES BROUGHT TO THE IMMEDIATE ATTENTION OF THE
- 04. MEASURING AND LAYOUT: WRITTEN DIMENSIONS SHALL PREVAIL OVER HAND MEASURED DIMENSIONS, & LARGER SCALED DRAWINGS SHALL PREVAIL OVER SMALLER SCALED DRAWINGS. MEASUREMENTS ARE TO THE OUTSIDE FACE OF BUILDING & FOUNDATION WALLS, FINISHED FACES OF CURBS & WALLS, & INSIDE FACE OF POOL WALLS. ALL DIMENSIONS LABELED WITH " + / " & "VIF" SHALL BE VERIFIED IN THE FIELD.
- 05. WORK: SHALL BE PERFORMED IN ACCORDANCE WITH INDUSTRY STANDARD MATERIALS & METHODS, EQUIPMENT APPROPRIATE FOR THE NATURE & SCOPE OF THIS PROJECT, SKILLED LABOR, & IN COMPLIANCE WITH RELEVANT FEDERAL, STATE, & LOCAL CODE.
- 06. WORK AREAS: EQUIPMENT, MATERIALS, STOCKPILES, & WORK AREAS SHALL BE NEATLY STAGED & KEPT CLEAN & SAFE IN A MANNER SO AS TO BE MINIMALLY DISRUPTIVE TO THE OWNER & OTHER PROJECT REPRESENTATIVES. UNSUITABLE SOILS, DEMOLISHED MATERIALS, ETC. SHALL BE DISPOSED OF IN A TIMELY LEGAL & RESPONSIBLE MANNER.
- MATERIALS, ETC SHALL BE DISPOSED OF IN A TIMELY, LEGAL & RESPONSIBLE MANNER.

  07. SUBSTITUTIONS: SHALL BE REQUESTED IN WRITING & APPROVED BY THE LANDSCAPE

ARCHITECT PRIOR TO PURCHASE & INSTALLATION.

#### ZONING DATA CHART: ZONE R-2

ITEM	PERMITTED	EXISTING	PROPOSED
MIN. LOT SIZE	2 ACRES (87,120 SF)	1.003 ACRES (43,700 SF)	NO CHANGE
POOL SETBACKS			
ONE SIDE	35'	N/A	75.83'
BOTH SIDES	70' TOTAL	N/A	156.66'
REAR SETBACK	50'	N/A	72.25'
BLDG COVERAGE	20% OR 8,740 SF	8.5% OR 3,720 SF	12.5% OR 5,456 SF

NOTES: PROPOSED TOTALS ARE INCLUSIVE OF, NOT IN ADDITION TO, EXISTING NUMBERS.

#### CONSTRUCTION SEQUENCE

- 01. MARK BOUNDARY OF WORK TO BE PERFORMED & CONTACT DIG SAFE (OR RELEVANT AGENCY) 72 HRS PRIOR TO BREAKING GROUND TO VERIFY LOCATION OF U.G. UTILITIES.
- 02. INSTALL SITE PROTECTION MEASURES: SILT FENCE, ANTI-TRACK PAD, TREE PROTECTION, CONSTRUCTION FENCE, ETC; IF REQUIRED, SCHEDULE INSPECTION.
- 03. DEMOLISH EXISTING STRUCTURES, FEATURES, VEGETATION, ETC. AS REQUIRED. DECONSTRUCT MATERIALS SPECIFIED FOR LATER USE & STAGE NEATLY IN APPROVED

AREAS. STRIP & STOCKPILE TOPSOIL IN SPECIFIED AREA; SEE GRADING NOTES.

IRRIGATION, PLUMBING, & ELECTRICAL) TO RUN CONCURRENTLY WHEREVER

- 04. LAYOUT & EXCAVATION: MEASURE & MARK OUTLINES OF DESIGN FEATURES WITH APPROPRIATE OVER DIG MARGINS. EXCAVATE & STAGE CAST MATERIALS FOR LATER
- USE OR TRANSPORT OFF SITE.

  05. FOOTINGS & FOUNDATIONS: FORMWORK, STEELWORK, CONCRETE POURS, & GUNITE POOL & SPA SHELLS. INSTALLATION OF REQUISITE UTILITY FEATURES (DRAINAGE,
- APPLICABLE. BACKFILL & INSTALL BASE MATERIALS FOR FINISH TREATMENTS.

  06. ABOVE-GRADE HARDSCAPE SYSTEMS: INSTALL TERRACES & WALLS, STOOPS & STAIRS, FIRE PITS, PERGOLAS, WATER FEATURES, GRILLS, ETC WITH REQUISITE UTILITY

FEATURES AS REQUIRED.

- 07. AT-OR-NEAR-GRADE HARDSCAPE SYSTEMS: POOL COPING, WET & DRY PAVING SYSTEMS, CURBS, APRONS, DRIVEWAYS, ETC. TO RUN CONCURRENTLY WITH REQUISITE UTILITY FEATURE INSTALLATIONS.
- 08. SEEDING & PLANTING: SPREAD TOPSOIL & FINE GRADE ALL LANDSCAPED AREAS; SEED & PLANT AS REQUIRED. (REFERENCE PLANTING NOTES).
- 09. PROJECT CLOSEOUT: REMOVE EROSION CONTROL MEASURES, FINAL CLEANUP, & WALK THROUGH WITH OWNER, LANDSCAPE ARCHITECT, & OTHER RELEVANT PROJECT REPS.

### EROSION CONTROL NOTES

- 01. PRIOR TO THE COMMENCEMENT OF ANY WORK, SITE PROTECTION MEASURES SHALL BE INSTALLED & PRESENTED FOR INSPECTION BY RELEVANT REGULATORY AGENCIES. CONTRACTOR SHALL INSPECT, MAINTAIN, & REPAIR PROTECTION MEASURES ACROSS THE DURATION OF THE PROJECT.
- 02. NO DISTURBANCES OF ANY KIND SHALL OCCUR OUTSIDE THE APPROVED BOUNDARY OF WORK TO BE PERFORMED. RE STABILIZATION, WHENEVER REQUIRED, SHALL BE SCHEDULED AND PERFORMED AS SOON AS POSSIBLE.
- 03. DISTURBED AREAS EXPOSED FOR MORE THEN 30 DAYS SHALL BE PROTECTED WITH TEMPORARY VEGETATIVE COVER & SEEDED WITH ANNUAL RYE GRASS AT A RATE OF 1 LB PER 1,000 SF OR 40 LBS PER ACRE.


### DEMOLITION WORK ITEM LEGEND


- 1 LIMIT OF DISTURBANCE / BOUNDARY OF WORK TO BE PERFORMED.
- 2 OUTLINE OF 18' X 36' PROPOSED POOL (INCLUDING 2' WIDE COPING).
- 3 SILT FENCE: PROVIDE 150 LF & INSTALL DOWNHILL OF DISTURBED AREAS.


  4 ANTI-TRACKING PAD: PROVIDE 6 TONS OF NO. 3 CRUSHED STONE.
- 5 SOIL STOCKPILE AREA 4' HT MAX: PROVIDE PERIMETER SILT FENCE.
- 6 REMOVE PORTION OF PERIMETER SITTING WALL ON EXISTING PATIO.
- 7 EXIST. LAWN OUTLINE: PROPOSED ACTIVITY NOT IN HEALTHY WETLAND.
- 8 EXIST. ABOVE GROUND PROPANE TANKS TO BE REPLACED WITH U.G. TANK.

SCALE: 1/16" = 1' - 0"

- 9 INTENTIONALLY BLANK
- 10 INTENTIONALLY BLANK

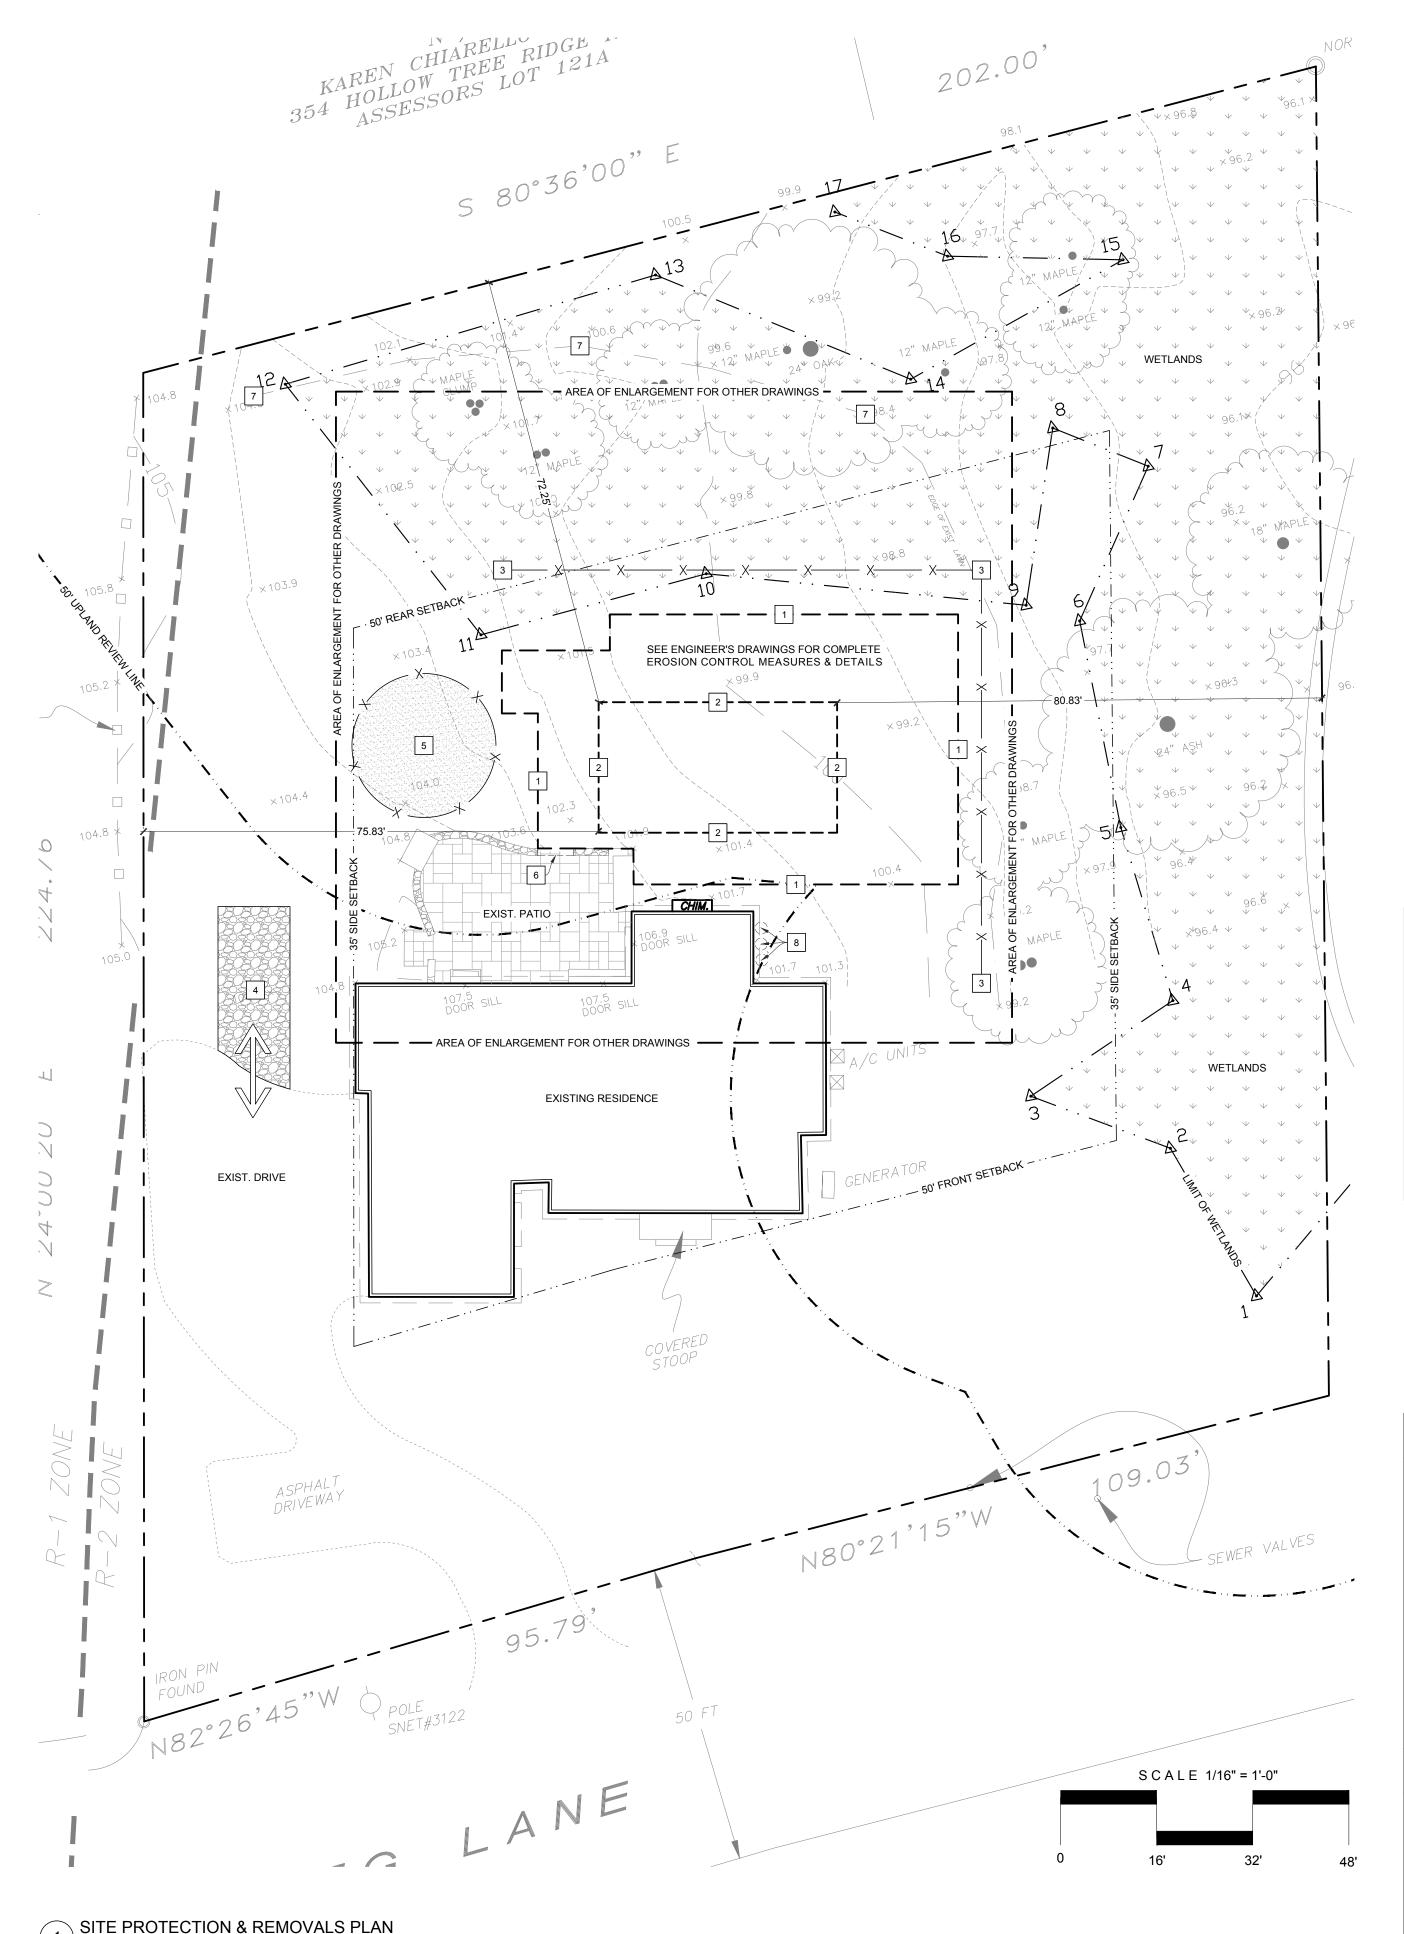

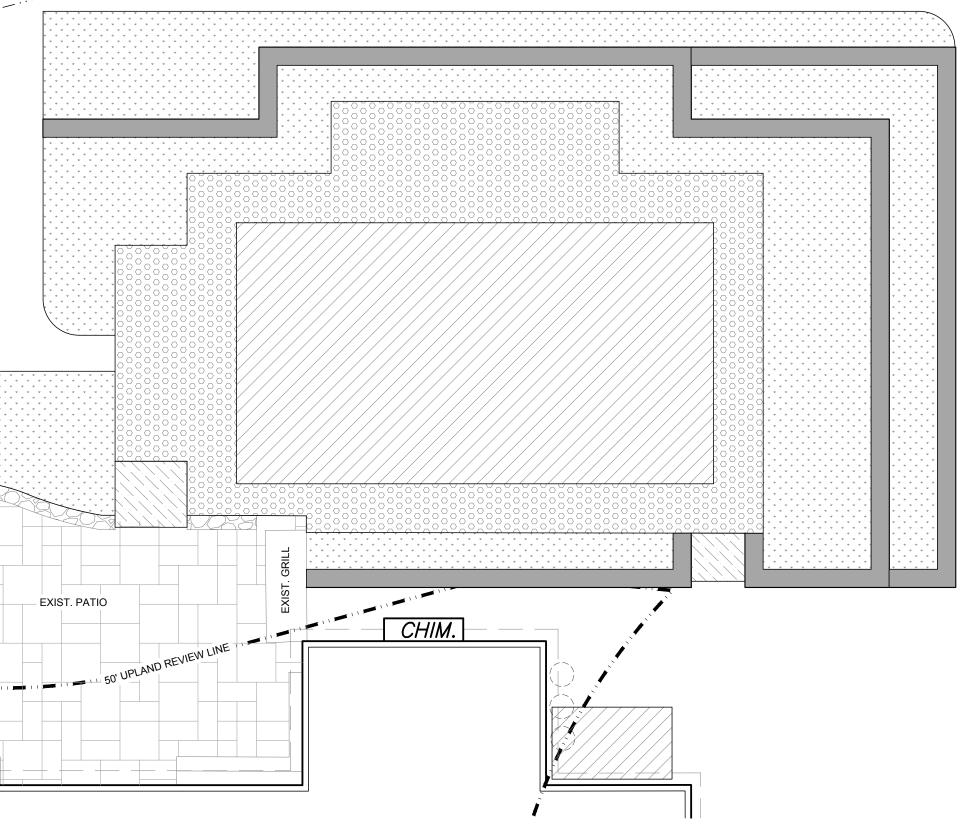

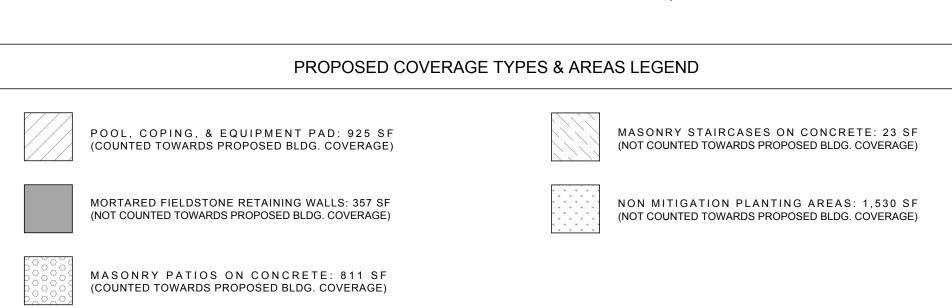

PROPOSED COVERAGE TYPES & AREAS DIAGRAM SCALE: 1/8" = 1' - 0"

# TABLE OF ABBREVIATIONS

KEY	DESCRIPTION
APPX	APPROXIMATELY
BLDG	BUILDING
BSMT	BASEMENT
BSTN	BLUESTONE
CMU	CONCRETE MASONRY UNIT
CONC	CONCRETE
FTG	FOOTING
LF	LINEAR FOOT
MIN	MINIMUM
MAX	MAXIMUM
NTS	NOT TO SCALE
POB	POINT OF BEGINNING
PL	PROPERTY LINE
R	RADIUS
RET	RETAINING
RP	RADIUS POINT
SQ	SQUARE
SF	SQUARE FOOT
TYP	TYPICAL

### CONTRACTOR LEGEND

VERIFY IN FIELD

ŒY	DESCRIPTION	
ARCH	ARCHITECT / ARCHITECTURAL	
C	ELECTRICAL CONTRACTOR	
NG	ENGINEER / ENGINEERING	
GC .	GENERAL CONTRACTOR	
.A	LANDSCAPE ARCHITECT	
.C	LANDSCAPE CONTRACTOR	
ΛС	MASONRY CONTRACTOR	
C	POOL CONTRACTOR	



### TABLE OF DRAWINGS

LA-100... SITE PROTECTION & REMOVALS PLAN
LA-200... LAYOUT, GRADING, & DRAINAGE PLANS
LA-201... ENCLOSURE FENCE PLAN
LA-300... PLANTING & LIGHTING PLANS
LA-301... MITIGATION PLANTING PLAN
LA-401... ELEVATIONS, SECTIONS, & DETAILS



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HATFIELD RESIDENCE

6 NUTMEG LANE DARIEN, CT


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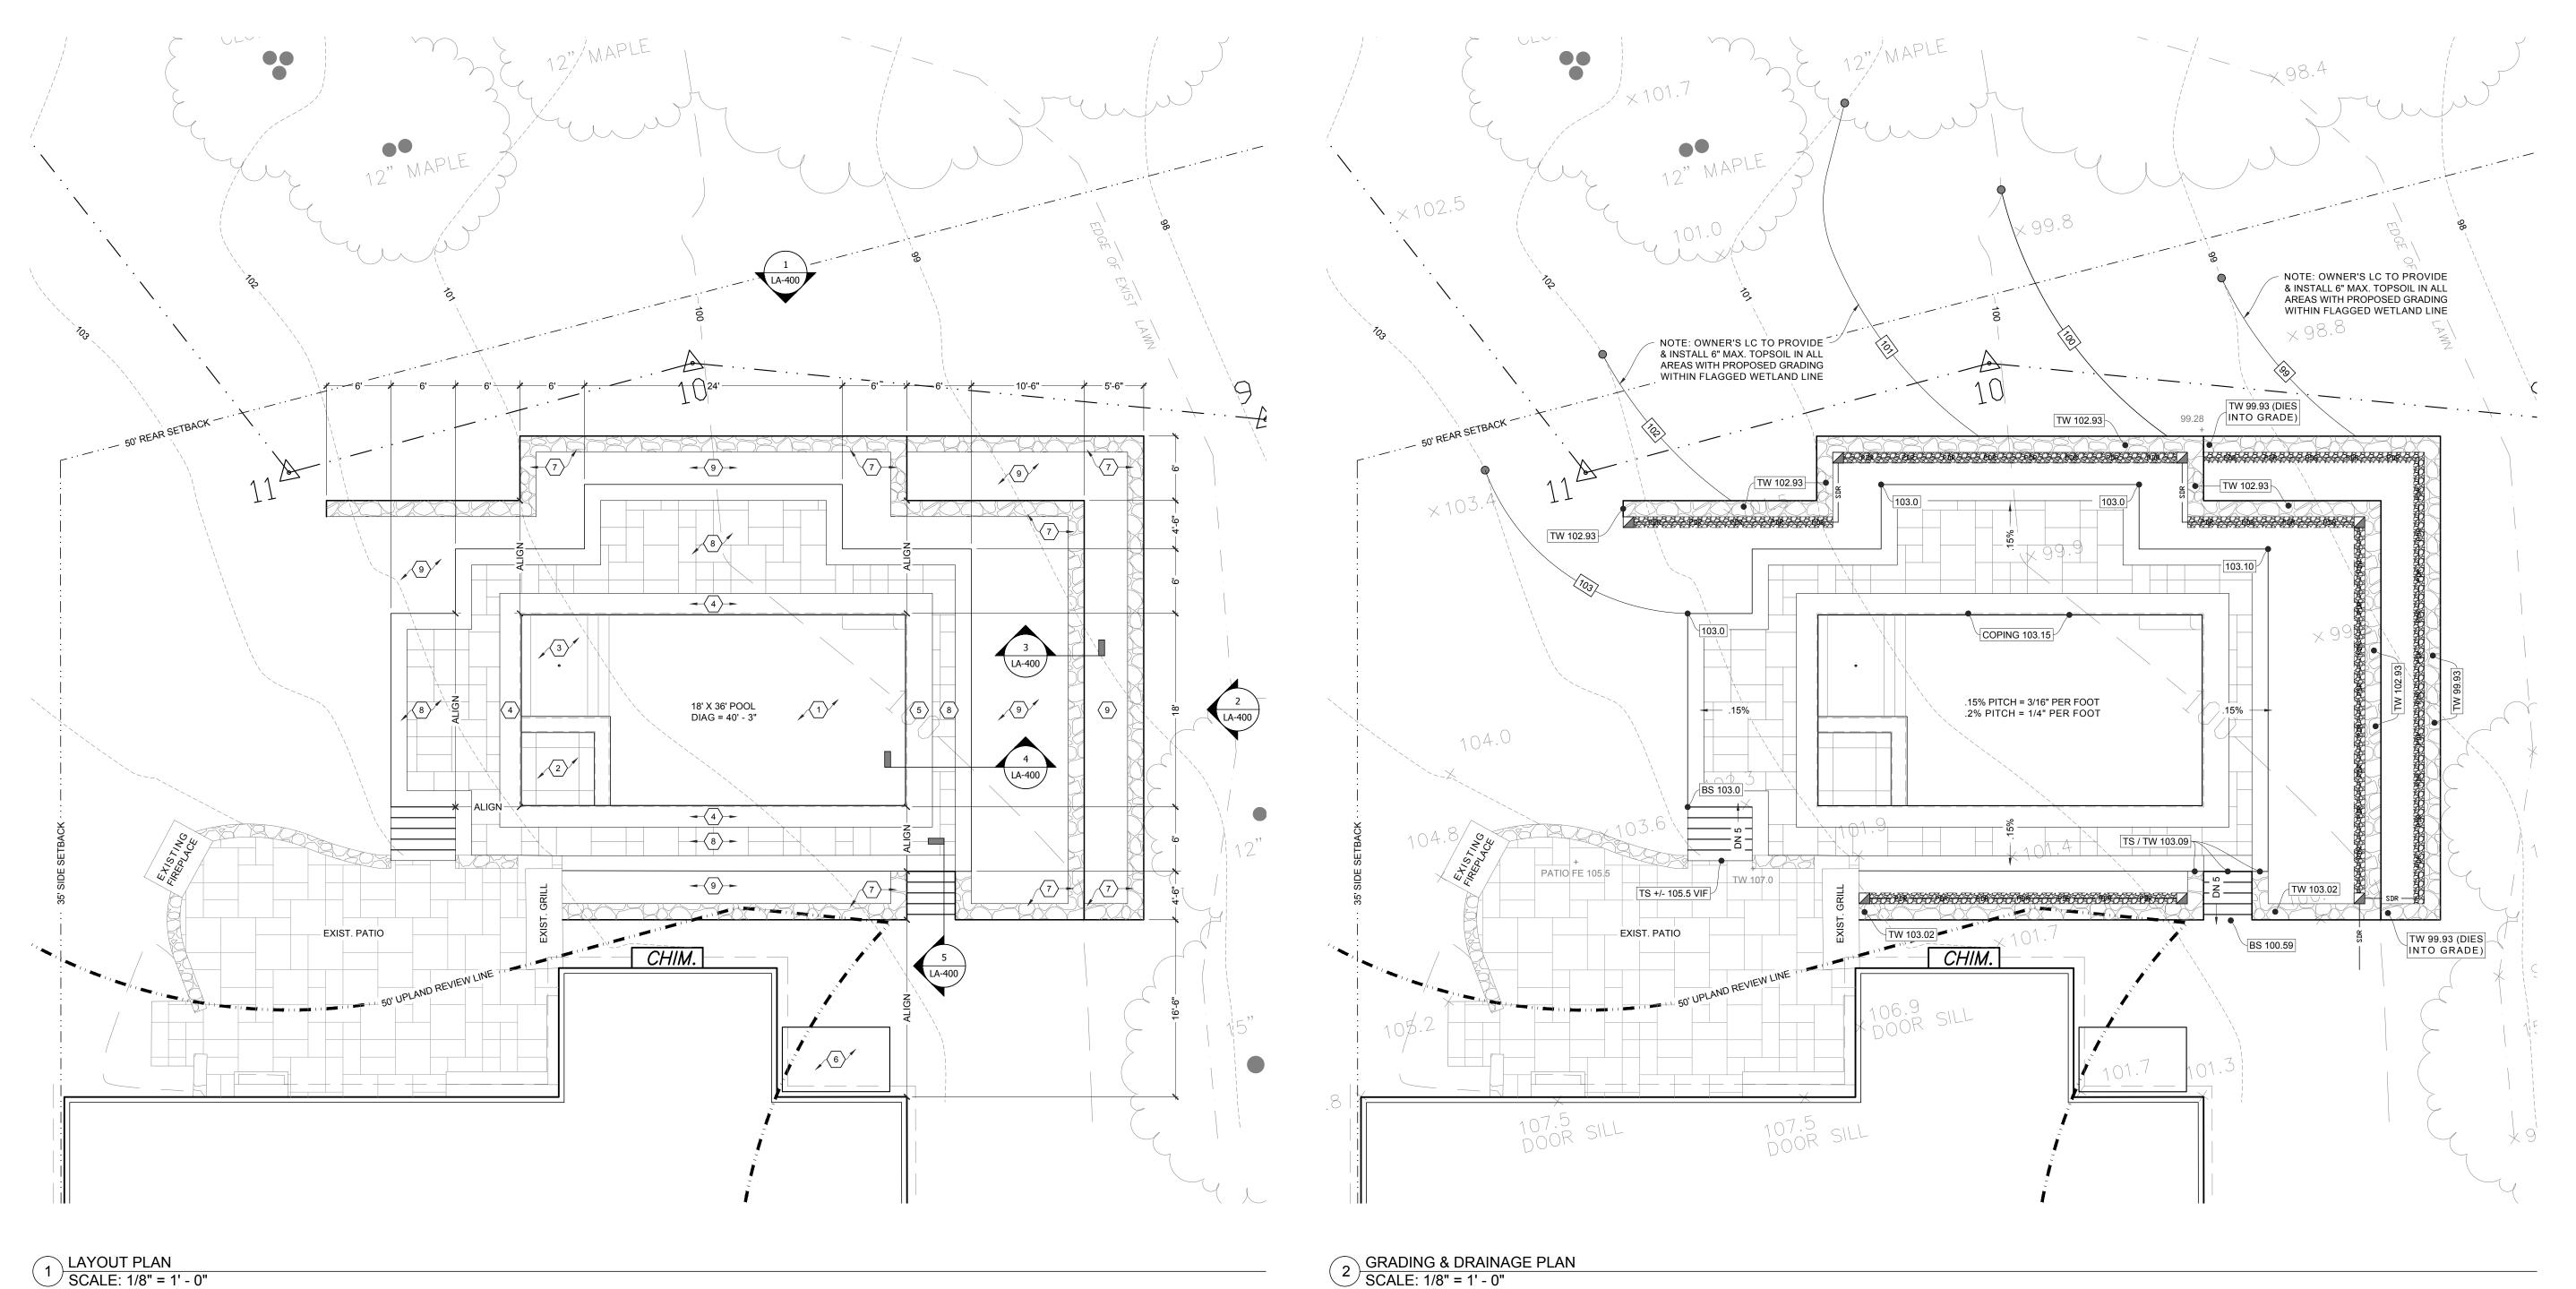
SITE
PROTECTION &
REMOVALS PLAN

<u>0</u>	Revisions or Type of Drawing Submittal	Date:
	SW: Provided as Design Concept Drawing	11-04-20
	SW: Design Development executed via Zoom meeting with Owners	12-07-20
	SW: Provided as Master Plan & bid drawings	12-07-20
	SW: Provided as Working Drawings	02-13-20

Date:	November 3, 2020
Drawn By:	SW
Checked By:	N/A
Scale:	1/16" = 1' - 0"
North:	Sheet:



LA-100

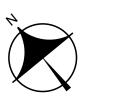

SCALE: 1/8" = 1' - 0

10 - INTENTIONALLY BLANK

#### LAYOUT WORK ITEM LEGEND

# 01. ROUGH GRADING: REFERS TO LARGE QUANTITIES OF EARTH MOVING & BULK EXCAVATION. SOIL STOCKPILE AREAS SHALL BE DETERMINED BY THE LA OR SITE

**GRADING NOTES** 

- EXCAVATION. SOIL STOCKPILE AREAS SHALL BE DETERMINED BY THE LA OR SITE ENGINEER & ARE NOT TO EXCEED 4' IN HEIGHT OR LEFT STANDING FOR MORE THAN 6 MONTHS. PROVIDE TEMPORARY SEEDING FOR ANY STOCKPILE TO REMAIN LONGER THAN 30 DAYS. ROUGH GRADING OPERATIONS SHALL NOT OCCUR IN WET CONDITIONS OR WITHIN THE DRIPLINES OF EXISTING TREES TO REMAIN.
- 02. FINE GRADING: INCLUDES BACKFILLING & OTHER WORK REQUIRED TO BRING SUB GRADES TO WITHIN SPECIFIED TOLERANCES FOR FINISH TREATMENTS. BACKFILLING SHALL BE DONE INCREMENTALLY IN 6" LIFTS COMPACTED TO 95%, WITH UNIFORM FILL MATERIALS TO PREVENT DIFFERENTIAL SETTLING.
- 03. FINISH GRADING: REFERS TO SURFACE TREATMENTS LIKE PAVING SYSTEMS, PLANTING BEDS, & LAWNS; ALL FINISHED GRADES SHALL SLOPE & DRAIN AS SPECIFIED. NEWLY INSTALLED TOPSOIL SHALL BE FREE OF LITTER, TRASH, DEBRIS, & ORGANIC MATTER MORE THAN 1" IN ANY DIMENSION. WHERE SETTLING OR DAMAGE OCCURS WHILE UNDER WARRANTY, RETURN FINISHED SURFACES TO SPECIFIED TOLERANCES & ORIGINALLY-INTENDED CONDITIONS.

# GRADING LEGEND

DESCRIPTION BENCH MARK ELEV FE FFE ELEVATION FINISHED ELEVATION FINISHED FLOOR ELEVATION FINISHED GRADE INVERT ELEVATION TOP OF CURB BOTTOM OF CURB TOP OF FOOTING **BOTTOM OF FOOTING** TOP OF RAMP BOTTOM OF RAMP TOP OF STAIR BOTTOM OF STAIR BOTTOM OF WALL EXISTING CONTOUR (PROPOSED CONTOUR) EXISTING SPOT ELEVATION

PROPOSED SPOT ELEVATION

# DRAINAGE LEGEND

CEY DESCRIPTION

CB CATCH BASIN

CO CLEAN OUT

DI DRAIN INLET

D INSIDE DIAMETER

DD OUTSIDE DIAMETER

MID MICRO DRAIN


SD SLOT DRAIN

TD TRENCH DRAIN

PDR PERFORATED DRAIN PIPE

SOLID DRAIN PIPE

#### LINETYPE LEGEND

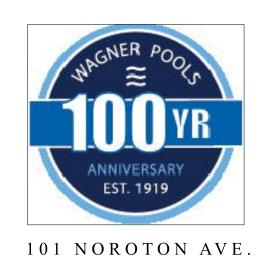

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# HATFIELD RESIDENCE

6 NUTMEG LANE DARIEN, CT


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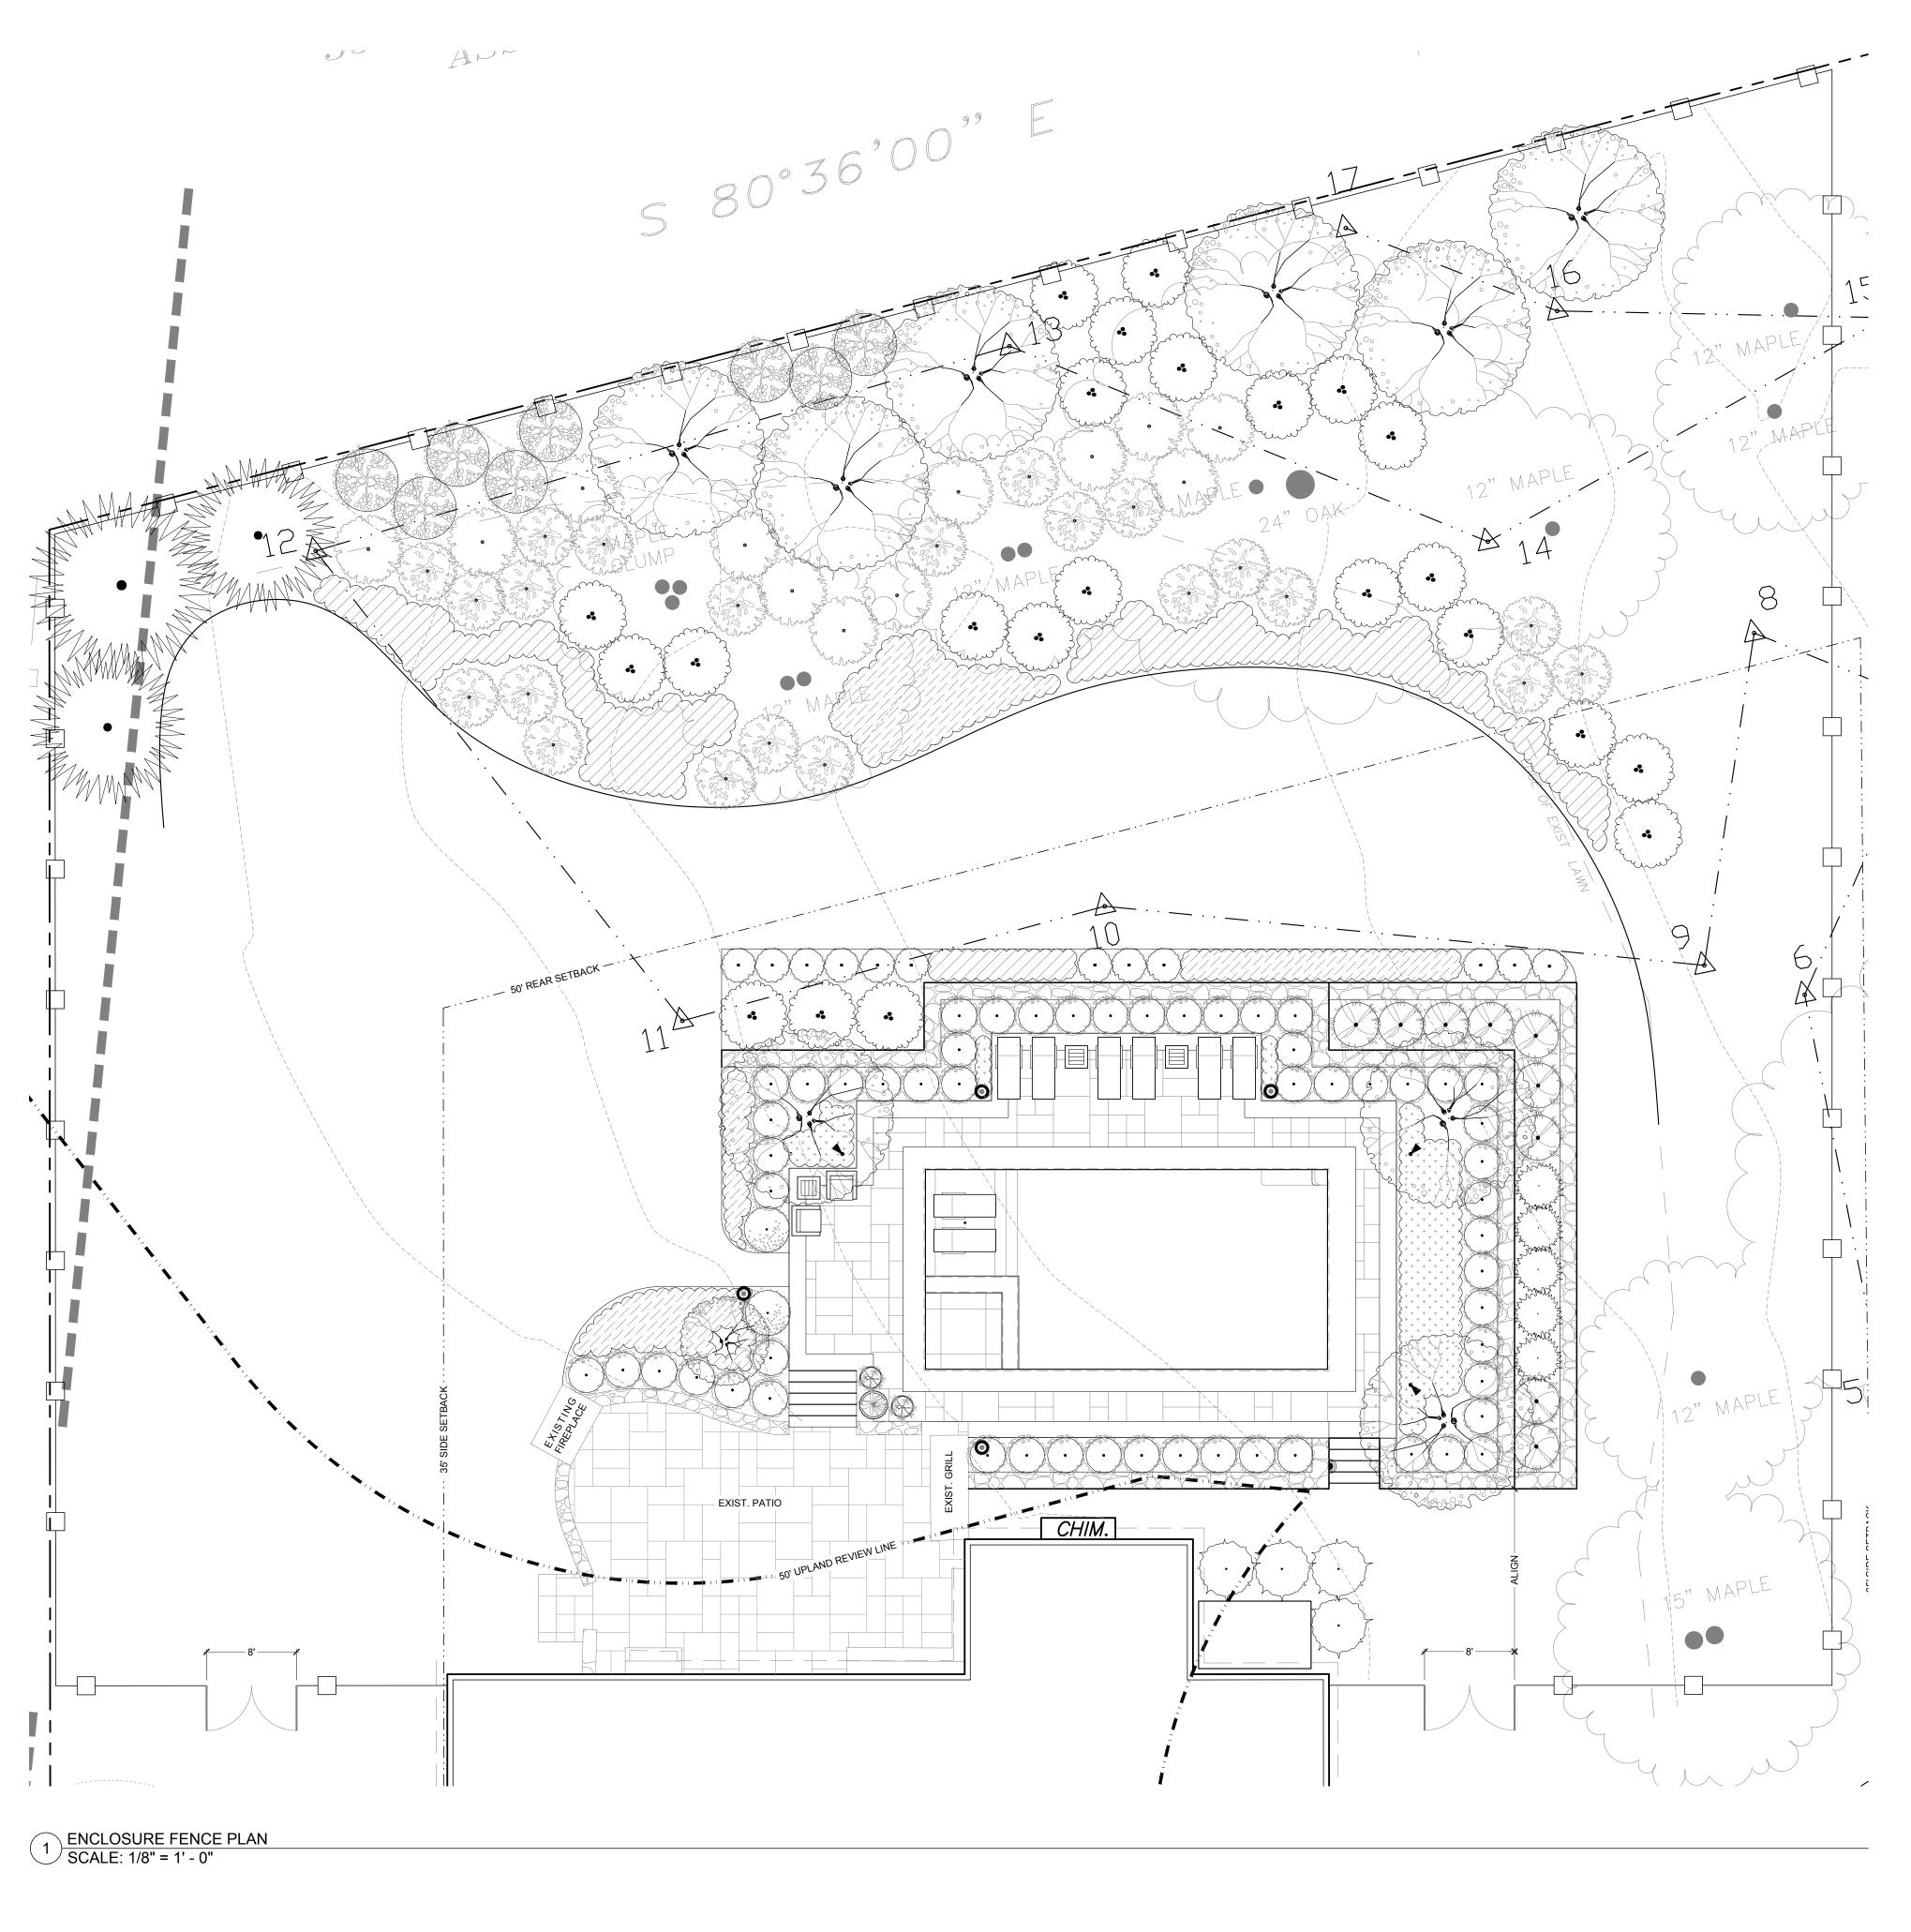
LAYOUT, GRADING, & DRAINAGE PLANS

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Checked By:	N/A
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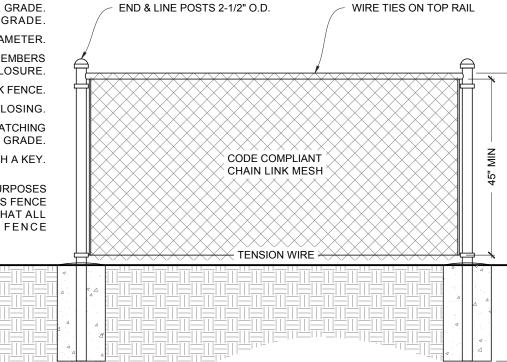


LA-200



R325.5.3 #1: TOP OF FENCE = MINIMUM 48" ABOVE GRADE. MAXIMUM 2" BETWEEN BOTTOM OF FENCE & GRADE. R325.5.3 #2: MAXIMUM OPENING IN FENCE = 4" DIAMETER. R325.5.3 #4: MINIMUM 45" BETWEEN HORIZONTAL MEMBERS WITH HORIZONTAL MEMBERS ON INSIDE OF ENCLOSURE. R325.5.3 #6: MAXIMUM 1-3/4" OPENING IN CHAIN LINK FENCE. R325.5.3 #8.1: GATES TO OPEN OUT & BE SELF CLOSING. R325.5.3 #8.2: GATES TO BE SELF-LATCHING WITH LATCHING MECHANISM LOCATED A MINIMUM OF 54" ABOVE GRADE. R325.5.3 #8.3: ALL GATES ABLE TO BE LOCKED WITH A KEY.

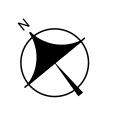ENCLOSURE FENCE DETAIL FOR ILLUSTRATIVE PURPOSES TO SHOW COMPLIANCY REQUIREMENTS. OWNER'S FENCE CONTRACTOR IS RESPONSIBLE FOR ENSURING THAT ALL FEDERAL, STATE, & LOCAL ENCLOSURE FENCE REQUIREMENTS ARE PROPERLY MET.



1 ENCLOSURE FENCE DETAIL FOR ILLUSTRATIVE PURPOSES SCALE: 1/2" = 1' - 0"





2 ENCLOSURE FENCE IMAGES: ALTERNATE WELDED WIRE DEER FENCE IMAGES PROVIDED BY THE FENCE FACTORY IN STAMFORD, CT

# POOL ENCLOSURE NOTES

- 01. POOLS & SPA AREAS SHALL BE COMPLETELY ENCLOSED BY A CODE-COMPLIANT BARRIER THAT OBSTRUCTS ACCESS TO ALL BUT INTENDED USERS & OCCUPANTS. BARRIERS MAY INCLUDE FENCES, WALLS, HOUSES, OR ANY COMBINATION THEREOF. PURSUANT TO THE UNIFORM CODE BARRIER REQUIREMENTS, THE FOLLOWING SPECIFICATIONS SHALL BE STRICTLY ADHERED TO, WITH NO DEVIATION, REGARDLESS OF THE DATE OF POOL & SPA INSTALLATION.
- 02. BARRIERS: SHALL (1) COMPLETELY SURROUND AND OBSTRUCT ACCESS TO POOL & SPA AREAS, (2) BE A MINIMUM OF 4' HIGH ABOVE RELATIVE GRADE, (3) SHALL NOT PROVIDE A SPACE GREATER THEN 2" BETWEEN THE BOTTOM OF THE BARRIER & GRADE, (4) NOT HAVE ANY OPENING GREATER THEN 4" ACROSS THE ENTIRE SURFACE AREA OF THE ENCLOSURE, & (5) SHALL NOT (A) BE LOCATED NEAR PERMANENT OBJECTS SUCH AS BRUSH PILES, TREES, MOUNDS, STRUCTURES, ETC THAT MAY BE USED TO FACILITATE ACCESS OVER THE ENCLOSURE, & (B) IN THE CASES OF SOLID ENCLOSURES LIKE MASONRY WALLS, OFFER ANY TOE HOLDS FOR ACCESS INTO THE ENCLOSURE.
- 03. BARRIER GATES: SHALL BE CONSTRUCTED SO AS TO (1) OPEN TOWARDS THE OUTSIDE OF THE ENCLOSURE, (2) BE SELF- CLOSING & LATCHING WITH THE LATCH ON THE POOL SIDE OF THE ENCLOSURE, (3) NOT HAVE ANY OPENINGS GREATER THEN .5" WITHIN 18" OF THE LATCH MECHANISM, (4) HAVE THE LATCH RELEASE MECHANISM A MIN OF 54" ABOVE GRADE, AND (5) INCORPORATE A ROBUST LOCKING MECHANISM REQUIRING A KEYED ENTRY.
- 04. WHERE BUILDING WALLS ARE PART OF THE BARRIER, AT LEAST ONE OF THE FOLLOWING REQUIREMENTS SHALL BE MET: (1) THE POOL MUST BE EQUIPPED WITH AN ASTM F1346 COMPLIANT POWERED AUTOMATIC SAFETY COVER, (2) ALL DOORS WITH DIRECT ACCESS TO THE POOL MUST BE EQUIPPED WITH AN ALARM THAT (A) PRODUCES AN AUDIBLE WARNING WHEN THE DOOR OR ITS SCREEN ARE OPENED, (B) SOUNDS CONTINUOUSLY FOR 30 SECONDS AFTER THE DOOR IS OPENED, (C) IS CAPABLE OF BEING HEARD THROUGHOUT THE HOUSE ACROSS NORMAL ACTIVITIES, (D) AUTOMATICALLY RESETS UNDER ALL CONDITIONS, & (E) IS EQUIPPED WITH A MANUAL MEANS OF DEACTIVATION LIKE A TOUCH PAD LOCATED A MINIMUM OF 54" ABOVE THE FLOOR, OR (3) OTHER MEANS OF PROTECTION SUCH AS SELF-CLOSING DOORS & LATCHES THAT OFFER A DEGREE OF PROTECTION NOT LESS THEN THAT DESCRIBED ABOVE, & ARE LOCALLY CODE COMPLIANT.
- DESCRIPTION OF THE ENGLOSUITE SHALL NOT EXCEED 1.75,"
  WHERE BARRIERS ARE COMPOSED OF HORIZONTAL & VERTICAL MEMBERS WITH LESS THEN 45" BETWEEN HORIZONTAL UNITS: HORIZONTAL UNITS SHALL BE LOCATED ON THE INSIDE OF THE ENCLOSURE, & SPACING BETWEEN VERTICAL UNITS & ACROSS DECORATIVE CUTOUTS SHALL NOT EXCEED 1.75,"
- 06. WHERE BARRIERS ARE COMPOSED OF HORIZONTAL & VERTICAL MEMBERS WITH 45" OR MORE BETWEEN HORIZONTAL UNITS: SPACING ACROSS VERTICAL UNITS SHALL NOT EXCEED 4" & SPACING ACROSS DECORATIVE CUTOUTS SHALL NOT EXCEED 1.75"
- O7. ADDITIONAL FENCE TYPES: (1) FOR CHAIN LINK FENCES MESH SIZES SHALL NOT EXCEED 2.25" SQUARE UNLESS THE FENCE IS FITTED WITH SLATS THAT REDUCE THE OPENINGS, & (2) FOR BARRIERS COMPOSED OF DIAGONAL MEMBERS SUCH AS LATTICE, THE OPENINGS BETWEEN UNITS SHALL NOT EXCEED 1.75"
- 08. EXCEPTIONS: BARRIERS FOR ABOVE-GROUND POOLS MAY BE MOUNTED ON THE POOL DECK PROVIDED THE SPACE BETWEEN THE TOP OF THE DECK AND BOTTOM OF THE BARRIER DOES NOT EXCEED 4". SPAS & HOT TUBS EQUIPPED WITH COVERS IN COMPLIANCE WITH ASTM F1364 ARE EXEMPT FROM ALL OTHER BARRIER REQUIREMENTS SO LONG AS THERE IS NO POOL.



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HATFIELD RESIDENCE

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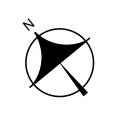
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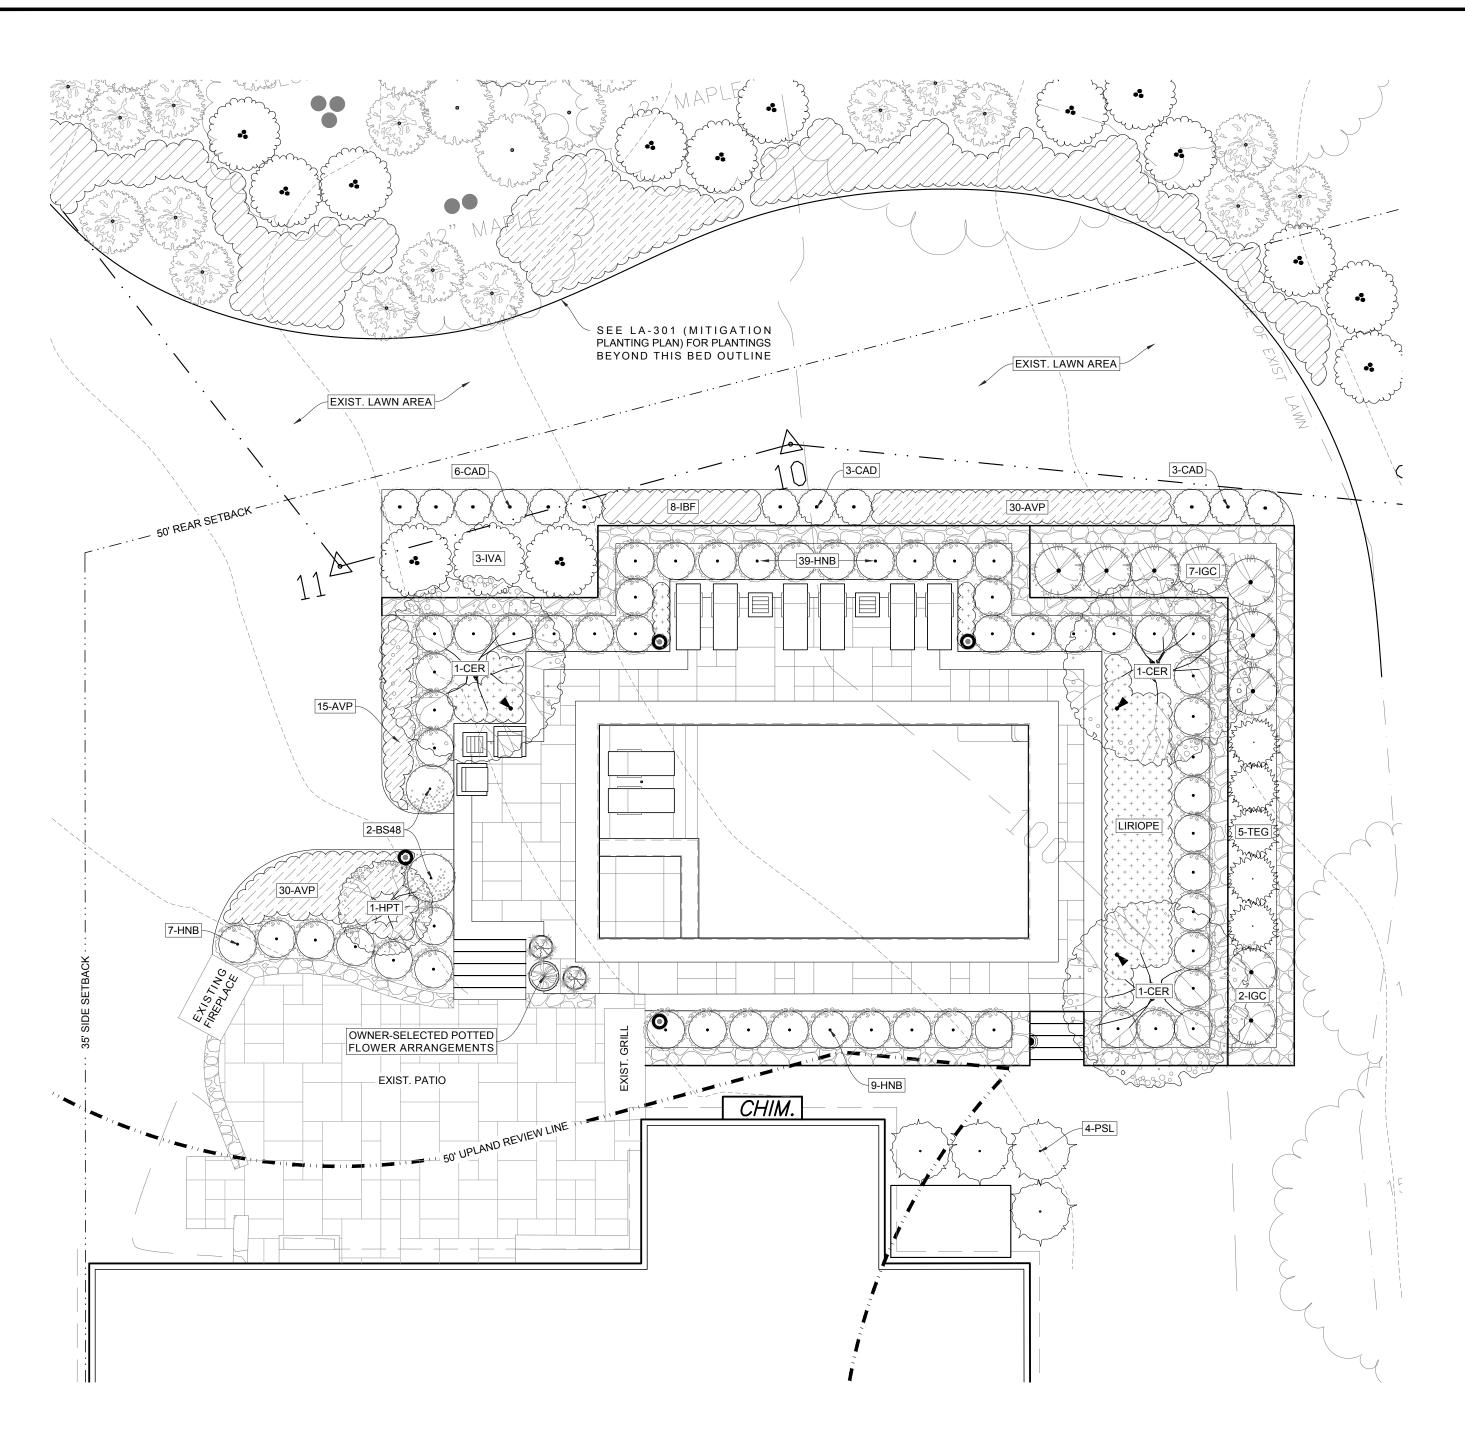
ENCLOSURE FENCE PLAN

NO.	NO. Revisions or Type of Drawing Submittal	Date:
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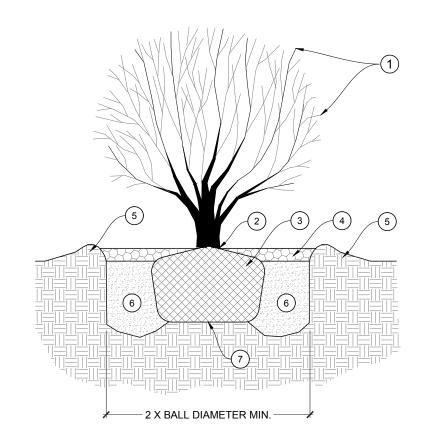
Date:	November 3, 2020
Drawn By:	SW
Checked By:	N/A
Scale:	1/8" = 1' - 0"



LA-201



PLANTING & LIGHTING PLAN SCALE: 1/8" = 1' - 0"



TREE & SHRUB PLANTING DETAIL

X SCALE: NTS

- 1) PRUNING ONLY TO REMOVE DEAD OR DAMAGED LIMBS, CO-DOMINANT LEADER, OR CROSSING & BRANCHES NOT CONFORMING TO HABIT.
- (2) TOP OF ROOT BALL SHALL BE SET FLUSH WITH ADJACENT GRADE OR SLIGHTLY HIGHER IN POORER SOILS. ROOT FLARE SHALL BE VISIBLE.
- REMOVE ROPE, TWINE, EXCESS SOIL, & BURLAP FROM TOP 1/3 OF ROOT BALL. REMOVE ALL NON-BIODEGRADABLE MATERIAL COMPLETELY FROM ROOT BALL.
- (4) MULCH WITH 3" DEEP PARTIALLY DECOMPOSED SHREDDED HARDWOOD MULCH, DARK IN COLOR (NO DYES) OR APPROVED SUBSTITUTE. DO NOT COVER ROOT FLARE.
- 5) 4" HIGH X MIN. DRIPLINE DIAMETER COMPACTED SOIL SAUCER BEYOND EDGE OF ROOT BALL.
- (6) PLANTING MIX: IN LOAMY SOILS BACKFILL WITH EXIST SOIL; IN SANDY SOILS ADD 20% MAX. ORGANIC MATTER. (ALERT LA IF POOR SOILS ARE PRESENT) TAMP WITH FOOT AND WATER IN
- (7) ROOT BALL TO REST ON UNDISTURBED OR COMPACTED SOIL TO PREVENT SETTLING. STAKING, GUYING AND WRAPPING TREES ONLY
- UPON THE APPROVAL OF THE LANDSCAPE ARCHITECT. DETAILS PROVIDED AS NECESSARY.

#### PLANTING NOTES

- SEEDING OPERATIONS TO OCCUR IN FAVORABLE WEATHER CONDITIONS.
- 2. SITE PREPARATION: ROTO-TILL, SCARIFY, OR AERATE ALL AREAS AFFECTED BY CONSTRUCTION PRIOR TO PLANTING & SEEDING OPERATIONS. PROVIDE & INSTALL MANUFACTURER-RECOMMENDED RATES.
- 03. COORDINATE WITH OWNER'S IRRIGATION CONTRACTOR (IF APPLICABLE) TO ENSURE NEWLY-PLANTED & SEEDED AREAS ARE PROPERLY IRRIGATED.

#### LIGHTING NOTES

- 2. PROVIDE & INSTALL REQUISITE FIXTURES & NECESSARY TRANSFORMER(S) WITH
- 3. LANDSCAPE LIGHTING SHALL BE INSTALLED BY, OR UNDER THE SUPERVISION OF, A LICENSED ELECTRICIAN & SHALL COMPLY WITH APPLICABLE CODE.
- 4. ALL WIRE RUNS SHALL BE BURIED IN CONDUIT 18" DEEP MIN. (RESIDENTIAL) & 24" DEEP MIN. (COMMERCIAL) MIN WITH FITTINGS CLEANED, PRIMED, & CEMENTED



REDBUD: EASTERN



SPRUCE: NORWAY (SHOWN ON LA-301)



ARBORVITAE: EMERALD GREEN



HYDRANGEA: NIKKO BLUE





CLETHRA ALNIFOLIA: HUMMINGBIRD, DWARF

SYMBOL QUANTITY





HOLLY: INKBERRY



LAUREL: SCHIP



HATFIELD RESIDENCE PLANTING SCHEDULE

**DECIDUOUS TREES** 

**EVERGREEN TREES** 

Norway Spruce

Norway Spruce

**DECIDUOUS SHRUBS** 

**EVERGREEN SHRUBS** 

**GROUNDCOVERS & PERENNIALS** 

Blue Flag Iris

Emerald Green Arborvitae

Dwarf Summersweet

Nikko Blue Hydrangea

Afterglow Winterberry

Common Boxwood

Schip Cherry Laurel

Visions Pink Astilbe

Dwarf Inkberry Holly

Pee Gee Hydrangea Tree

Eastern Redbud

COMMON NAME

BOTANICAL NAME

Thuja occidentalis 'Emerald Green'

Hydrangea macrophylla 'Nikko Blue'

Prunus laurocerasus 'Schipkaensis'

Astilbe chinensis 'Visions Pink'

Hydrangea paniculata grandiflora

Clethra alnifolia 'Hummingbird'

Ilex verticillata 'Afterglow'

Buxus sempervirens

Iris versicolor

Ilex glabra 'Compacta'

Cercis canadensis

Picea abies

Picea abies




BOXWOOD: COMMON, SPECIMEN









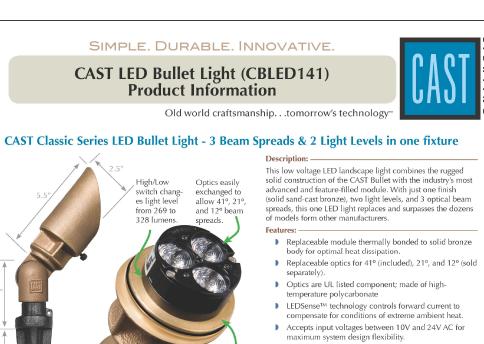

Provides a highly energy efficient LED light source that projects an evenly distributed beam with warm color temperature. Brightness and beam distribution are comparable to incandescent models of 20w and 35w. Fully rotatable extra-long shroud enables excellent glare control.

Dimensions & Weight: -Body and Shroud: 2.5" x 9" fully extended; Weight: 5 lb. ▶ FCC Compliant for EMI Interference LED Lamp Specifications: ----Construction: Body: Sand-cast solid bronze. take: Solid Black Coated Eurometal

Input Voltage: 10 to 24 V AC orDC Socket: High-temperature MR-16 socket Power Low Setting: Amps .52, Watts 5.86, Power Factor .93, Volt Glass: Flat, tempered, hardened, crytal clear glas Retaining Screw: Stainless steel Power High Setting: Amps .82, Watts 9.25, Power Factor .94, Volt Lumen Output Low Setting: 269 Optional Optics: (T-8 Torx Screwdriver Needed

Lumen Output High Setting: 328 C10139: 21° Medium Optic (Set of 3) Center Beam Candela Low setting: 781

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 Automatic recognition and compensation for varied Dimmable with standard low-voltage phase dimmers Warm white color temperature (2,720K) and high color rendering index (80 CRI) that closely matches

UL/CSA/RoHS recognized, FCC Class A Conducted and

incandescent lighting. L70 of 60,500 hours.

Revised August 2016



a soft glare-free illumination. LED conversion is Easily converted to LED by adding the

Glare Free light source Solid bronze hat and vase Solid black coated Eurometal stake Heavy-guage copper stem

Optional Sprinkler Shield ▶ Pre-wired with 25′ #16-2 tin-coated No-Ox® marine grade wire High-temp socket ▶ Spider Splice® ready

Suitable for lighting walkways, planting beds, and other areas.

NOTES

6' OC, anti-desiccant in winter

CCH1CB

Solid bronze hat and vase; black coated stake; 22" tall x 7" wide heavy-gauge copper stem; 25' tin-coated #16-2 No-Ox® marine-grade wire; Optional Lamp Specifications: ---solid bronze and borosilicate sprinkler guard CCH1CB: 12v Wedge Base Krypton (25w max.) 22 LED Conversion: CALED2 LED Module U.L 1838 Listed Low Voltage Luminaire for wet

SIZE

10'-12' ht, b&b 4' OC

3 gal cont.

10 gal cont.

4'-5' ht, b&b

6'-8' ht, b&b

1 gal cont.

1 gal cont.

0

www.cast-lighting.com 800.914.CAST © Copyright 2016, CAST Lighting LLC. All rights reserved.

All Versions: RoHs, FCC Class B Conducted and

3"-3.5" cal, b&b | single stem, full, purple leaf

10'-12' ht, b&b | spacing is equal to height

12'-14' ht, b&b spacing is equal to height

2"-2.5" cal, b&b single stem tree form

6' OC, heavy

48"-54" ht, b&b | spacing is equal to height

118" OC

2' OC

36"-42" ht, cont. 4' OC substitute 1 male

LED Versions: UL listed

101 NOROTON AVE

DARIEN, CT 06820

(203) 655-0766

If professional Seal is not in a contrasting color, this sheet is a copy.

HATFIELD

RESIDENCE

6 NUTMEG LANE

DARIEN, CT

The drawings, notes, & specifications contained herein are


instruments of professional service, protected under copyright


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PLANTING & LIGHTING PLAN

November 3, 2020 SWDrawn By: Checked By: N/A 1/8" = 1' - 0"





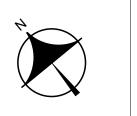


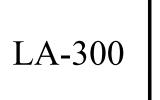1. BIDS SHALL INCLUDE SITE PREPARATION, PERCOLATION TESTS, PLANTING MEDIUMS, PLANT MATERIALS, TREE PITS, INSTALLATION, STAKING & GUYING, FERTILIZER, MULCH, & PLANT GUARANTEES. PLANTS SHALL EQUAL OR MEET NOTED SIZES, WITH PLANTING &

SPECIFIED QUANTITIES OF TOPSOIL, LOAM, & STARTER FERTILIZER AT THE

- 11. LIGHTING LOCATIONS ARE INTENDED FOR ILLUSTRATIVE PURPOSES & SHOULD BE FIELD LOCATED & COORDINATED WITH LANDSCAPE PLANTINGS & UNDERGROUND UTILITIES.
- ALTERNATIVE BULB WATTAGES AS REQUIRED BASED ON FIELD CONDITIONS.

- 05. NO LIGHTING SHALL BE WITHIN 5' OF A SWIMMING POOL OR WATER FEATURE; ALL LIGHTING WITHIN 5' - 10' OF ANY WATER FEATURE SHALL BE GFCI PROTECTED.

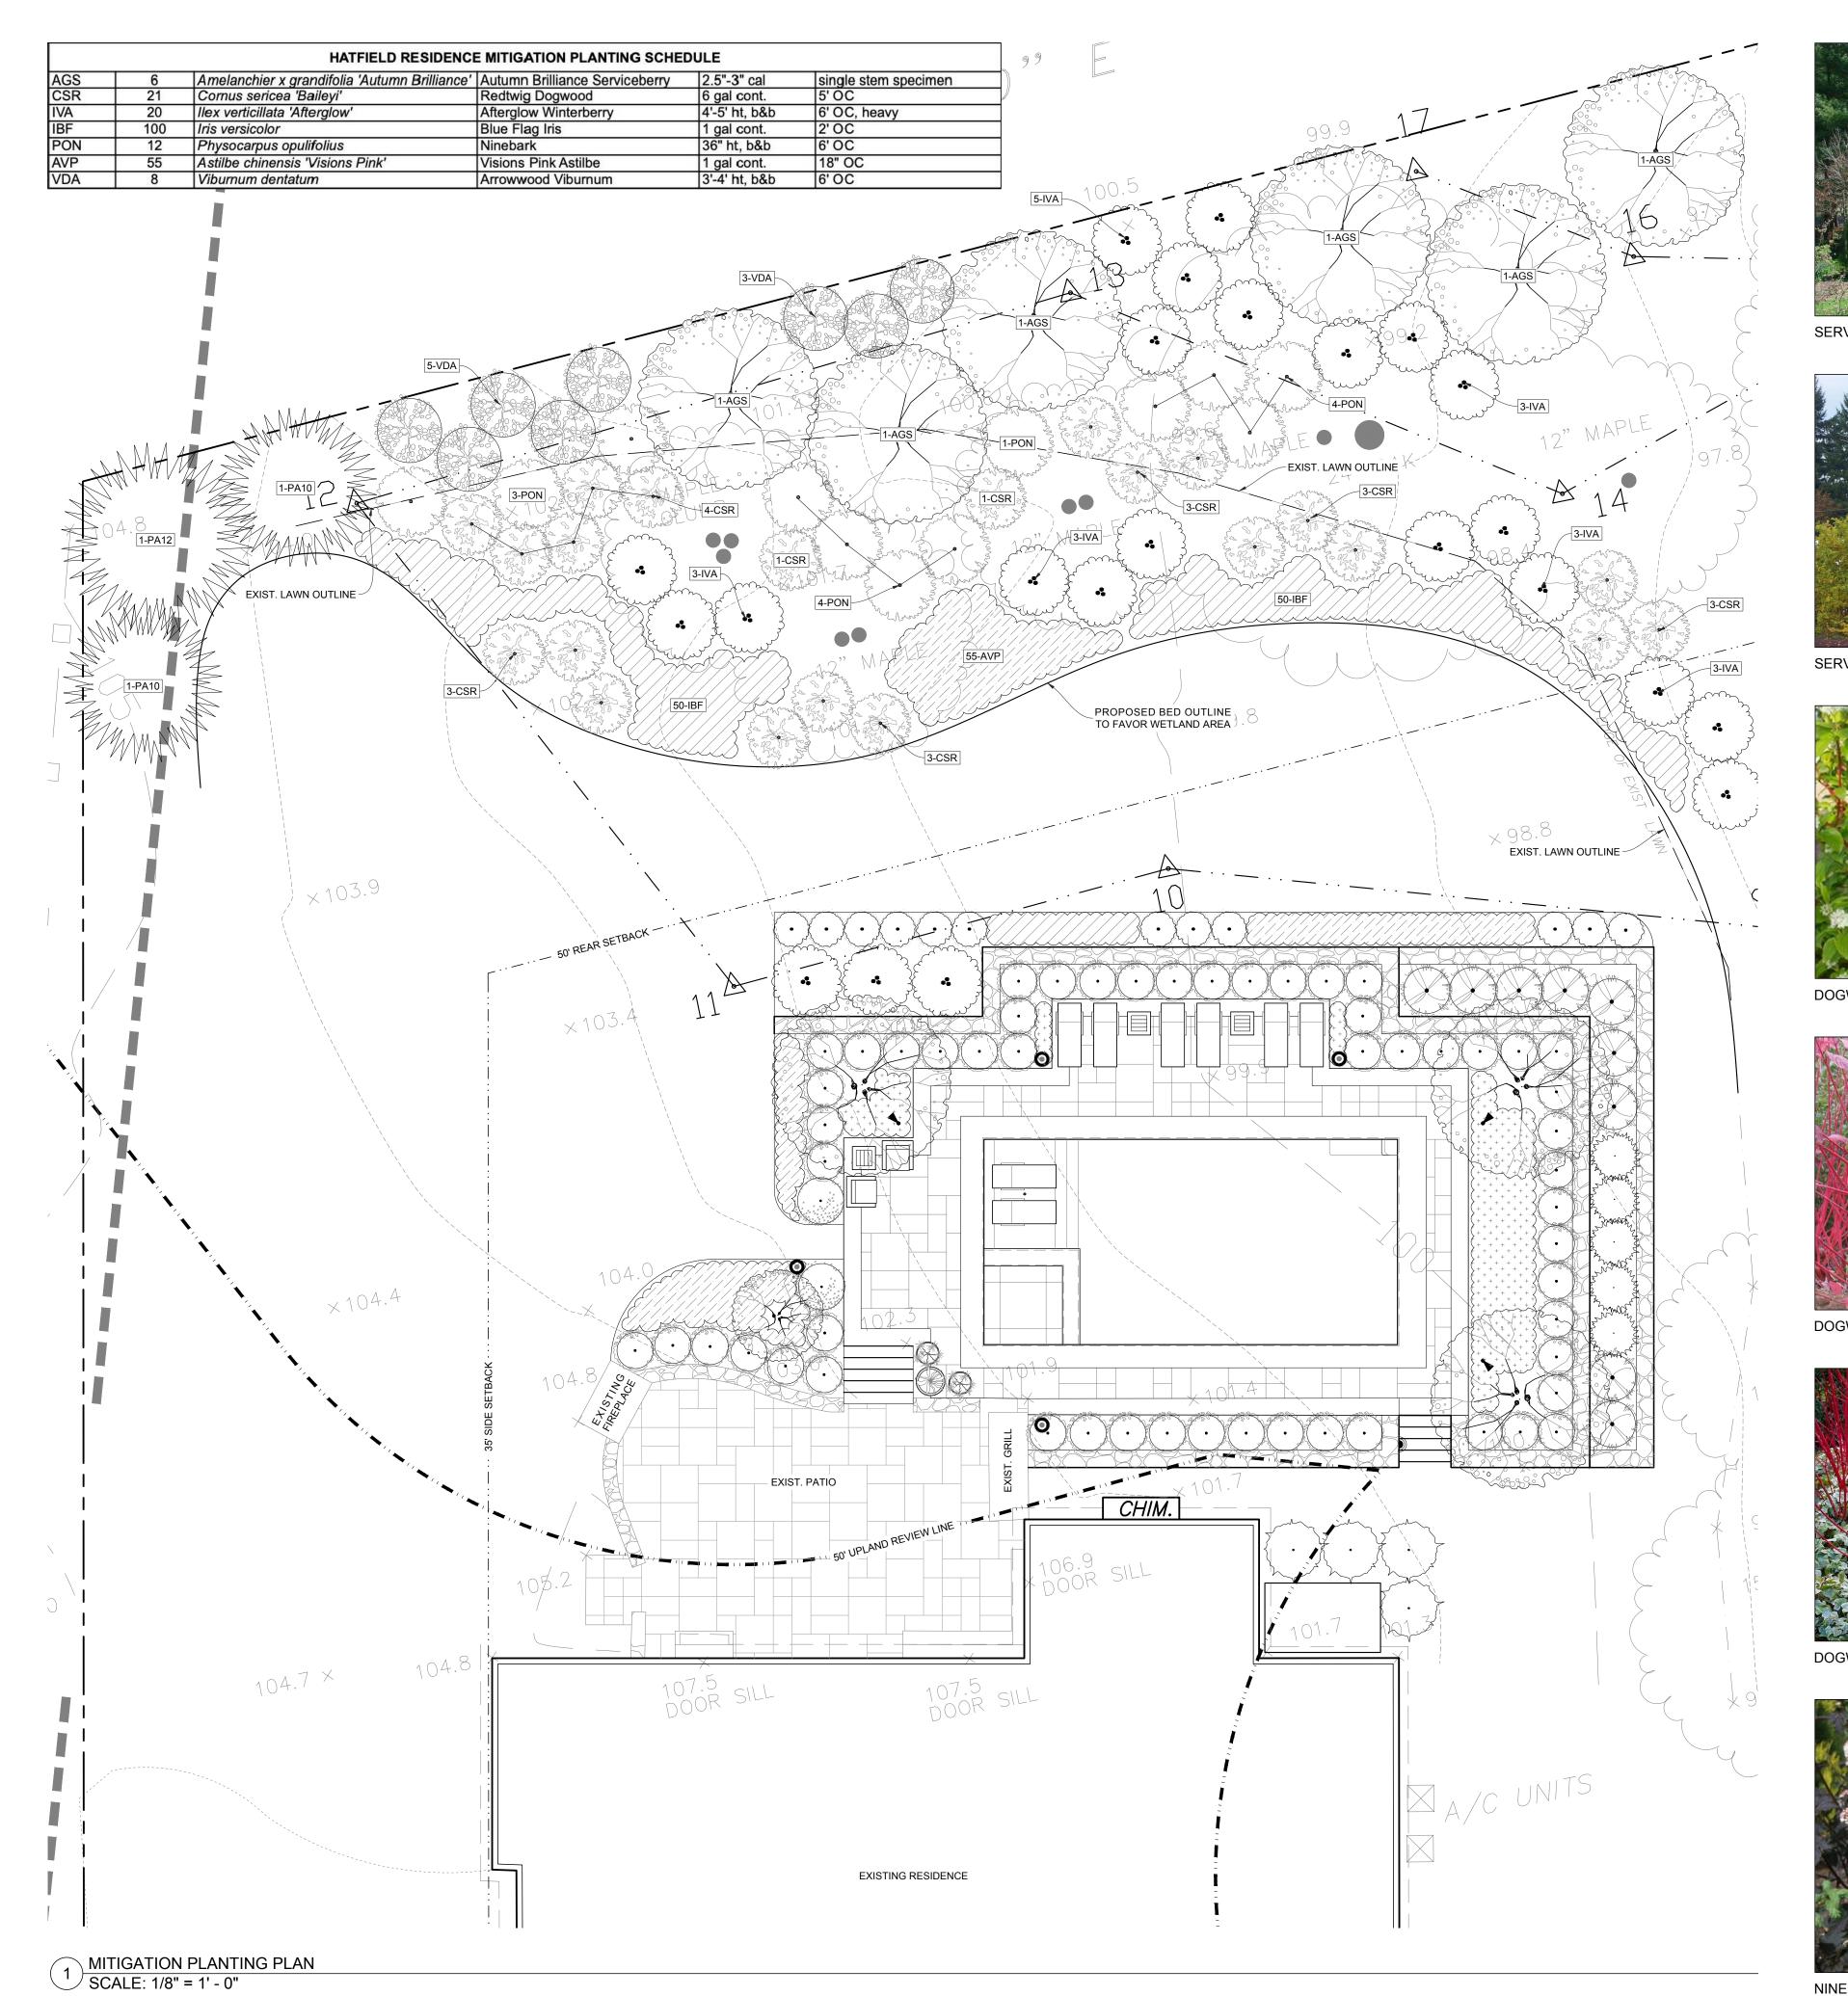







SERVICEBERRY: FALL



DOGWOOD: RED TWIG, SPRING



DOGWOOD: RED TWIG, FALL



DOGWOOD: RED TWIG, WINTER




NINEBARK



HOLLY: AFTERGLOW, WINTER



VIBURNUM: ARROWWOOD, SPRING

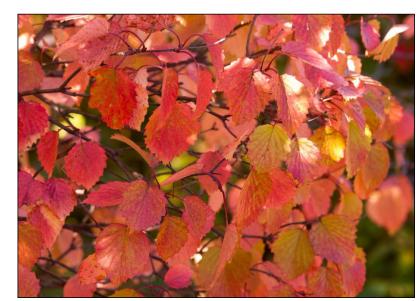

VIBURNUM: ARROWWOOD, FALL



ASTILBE: VISIONS PINK



IRIS: BLUE FLAG



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HATFIELD RESIDENCE


6 NUTMEG LANE DARIEN, CT

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MITIGATION PLANTING PLAN

Date:	
Revisions or Type of Drawing Submittal  SW: Provided as Design Concept Drawing  SW: Design Development executed via Zoom meeting with Owners  SW: Provided as Master Plan & bid drawings  SW: Provided as Working Drawings	meeting with Owners

Date.	November 3, 2020
Drawn By:	SW
Checked By:	N/A
Scale:	1/8" = 1' - 0"

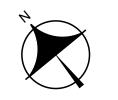

#### GENERAL DETAIL NOTES

- 01. CONCRETE: ALL CONCRETE SHALL BE AIR-ENTRAINED & INSTALLED IN ACCORDANCE WITH ACI 301 & 318. REINFORCING STEEL SHALL BE ASTM A6 15 GRADE 60 & HAVE 3" OF COVER FOR CONCRETE CAST ON EARTH & 2" FOR CONCRETE EXPOSED TO SOIL OR AIR. INSTALL PLASTIC CHAIRS & SPACERS FOR HORIZONTAL WOVEN MATRICES.
- 02. FOOTINGS: SHALL BEAR ON UNDISTURBED SOIL A MINIMUM OF 42" BELOW FINISHED GRADE OR BE PINNED DIRECTLY TO LEDGE USING A CONSTRUCTION ADHESIVE. INSTALL # 4 RE BAR @ 1' OC, BOTH WAYS, AS A HORIZONTAL WOVEN MATRIX. POUR AT 3,000 PSI & SLUMP NO MORE THAN 5".
- 03. FOUNDATIONS: INSTALL VERTICAL # 4 RE BAR @ 4' OC TIED INTO THE HORIZONTAL FOOTING MATRIX & A CONTINUOUS HORIZONTAL BOND BEAM ACROSS THE TOP OF THE FOUNDATION. POUR AT 3,000 PSI & SLUMP NO MORE THAN 5". FOR CMU FOUNDATIONS, INSTALL DURAWALL TRUSS UNITS EVERY OTHER COURSE & FILL ALL CAVITIES SOLID WITH CONCRETE.
- 04. SLABS: SHALL BEAR ON A 6" THICK BASE OF 3/4" TRAP ROCK COMPACTED IN LIFTS. INSTALL A #4 HORIZONTAL WOVEN MATRIX @ 1' OC BOTH WAYS WITH A 6" SQ. WOVEN WIRE MESH AFFIXED TO THE TOP. SLAB THICKNESS SCHEDULES ARE AS FOLLOWS: NON STRUCTURAL SLABS = 4" THICK MINIMUM, & STRUCTURAL SLABS = 6" THICK MINIMUM. POUR AT 4,500 PSI & SLUMP NO MORE THAN 4".
- 05. CONCRETE STAIRS: INSTALL #4 CONTINUOUS REBAR NOSING INTO EACH RISER. PITCH ALL TREADS A MINIMUM OF 1% TOWARDS LOWER RISERS OR LANDINGS. STAIR SLABS = 6" THICK MINIMUM.
- 06. STONE OR BRICK VENEER WALL UNITS: SHALL BE INSTALLED WITH STAINLESS STEEL WALL TIES CORRECTLY FIXED TO HORIZONTAL CMU JOINTS @ 16" OC BOTH WAYS (NOT SHOWN IN DRAWINGS).

#### NUMERIC DETAIL LEGEND

1) UNDISTURBED EARTH OR SUITABLE BASE MATERIAL COMPACTED TO 95%.

(2) AIR-ENTRAINED CONCRETE FOOTING @ 3,000 PSI & MAXIMUM # 5 SLUMP. #4 HORIZONTAL RE BAR WOVEN @ 1' OC BOTH WAYS (FOOTINGS & SLABS).

4) - # 4 VERTICAL RE BAR @ 4' OC ACROSS FOUNDATIONS & CMU CAVITIES.

(5) CMU OR CONCRETE FOUNDATION / STEM WAL; SEE NOTES ABOVE. 6 3/4" TRAP ROCK COMPACTED IN 6" LIFTS WITH THICKNESS AS INDICATED.

(8) CONCRETE SLAB @ 4,000 PSI & MAX # 5 SLUMP; THICKNESS AS SHOWN.

(9) MORTARED SETTING BED ON CONCRETE +/- 1" DEPTH OR AS INDICATED. 10) - PAVING UNITS: +/- 1-1/4" THICK THERMAL FLAGGING ON CONCRETE.

11) STONEWORK: USE STAINLESS STEEL WALL TIES @ 16" OC BOTH WAYS.

(12) WALL CAP: 2" THICK X 18" WIDE THERMAL BLSTN WITH 1.5" OVERHANG. (13) WATERPROOF MEMBRANE: +/- 1/2" STUCCO WITH THOROSEAL OR TAR.

(14) WALL DRAIN: SCHED. 35 PERF. DRAIN IN CRUSHED STONE & FILTER FABRIC. (15) CAST LED WALL LIGHT: SEE CUT SHEET ON PLANTING & LIGHTING PLAN.

16) - LOAM OR PLANTING MEDIUM INSTALLED IN UNIFORM DEPTH AS SHOWN. 17 MIN. 3" THICK BROWN (NON-DYED), QUALITY SHREDDED BARK MULCH.

EARTH / BACK FILL

LOAM / PLANTING MEDIUM 3/4" TRAP ROCK

CONCRETE


(18) - INTENTIONALLY BLANK.

EXPANSION JOINT BARK MULCH


HATCH SYMBOL LEGEND MORTAR BED PAVER OR CAP UNITS

-- 10'-6" PLANTER --→ 6' WALKWAY — – 36' POOL & RET. WALL -—12' PATIO & WALKWAY ————————————————6' PLANTING BED —— - LINE OF EXIST. GRADE — — POOL WATER LINE \_ \_\_ \_ \_ \_ LINE OF POOL BEYOND - -- - - LINE OF EXIST. GRADE -

NORTH ELEVATION & EXISTING SITE SECTION SCALE: 1/4" = 1' - 0"

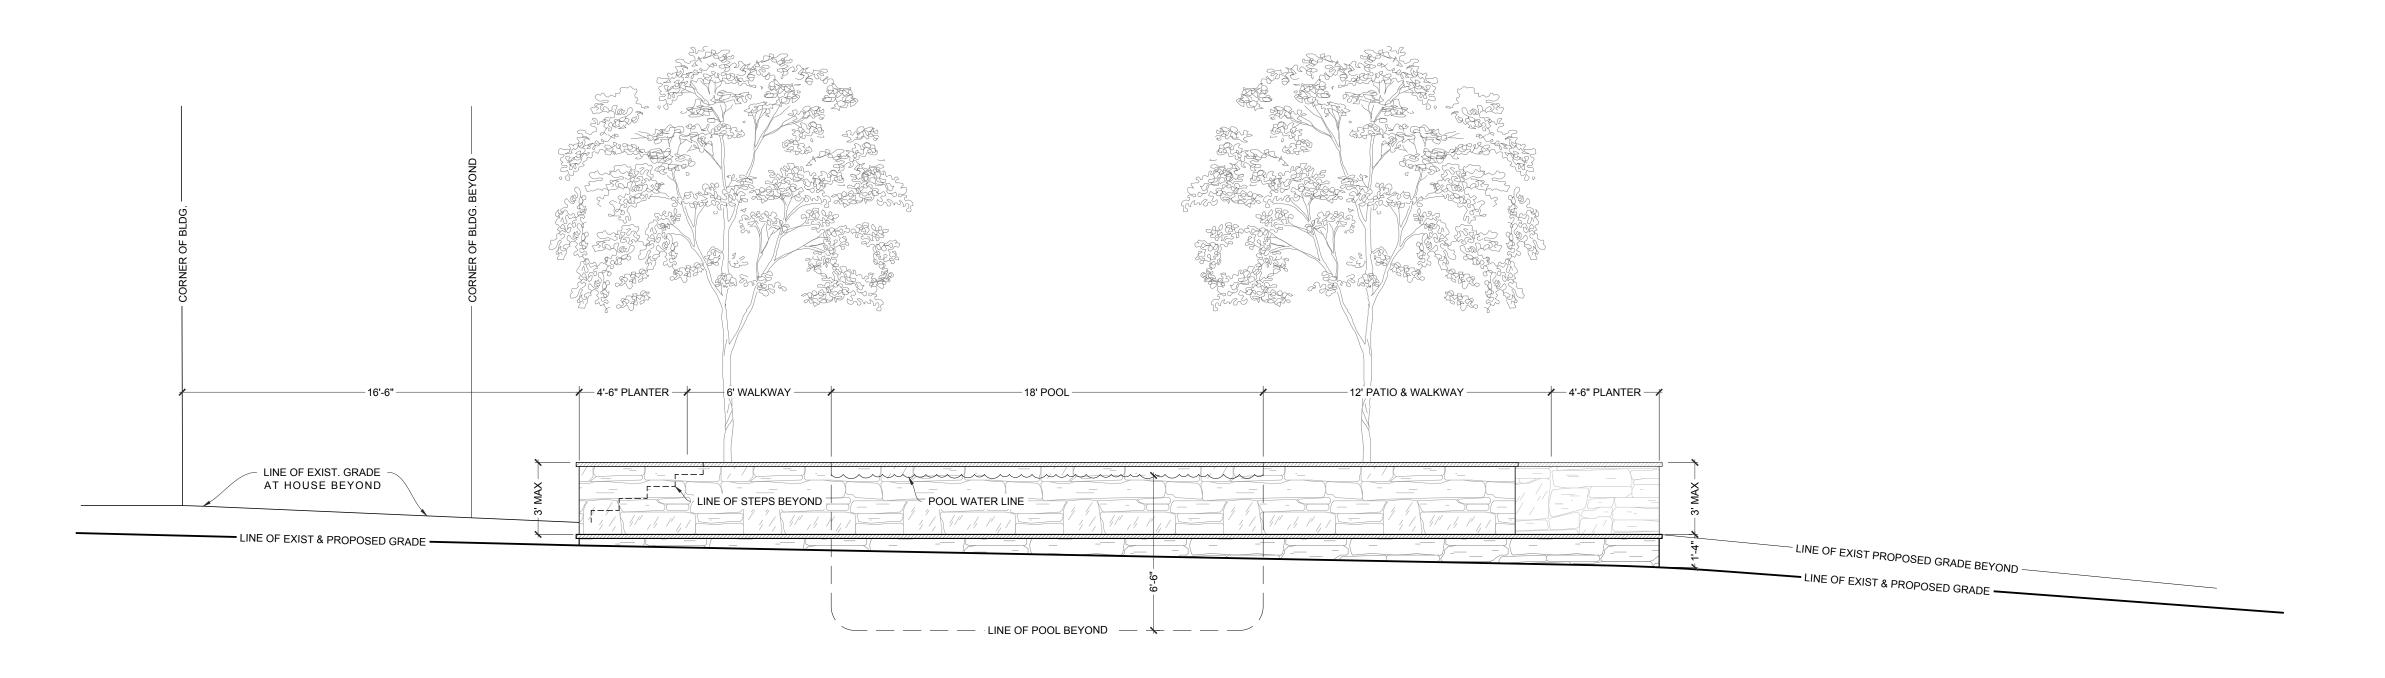

2 EAST ELEVATION & EXISTING SITE SECTION SCALE: 1/4" = 1' - 0"

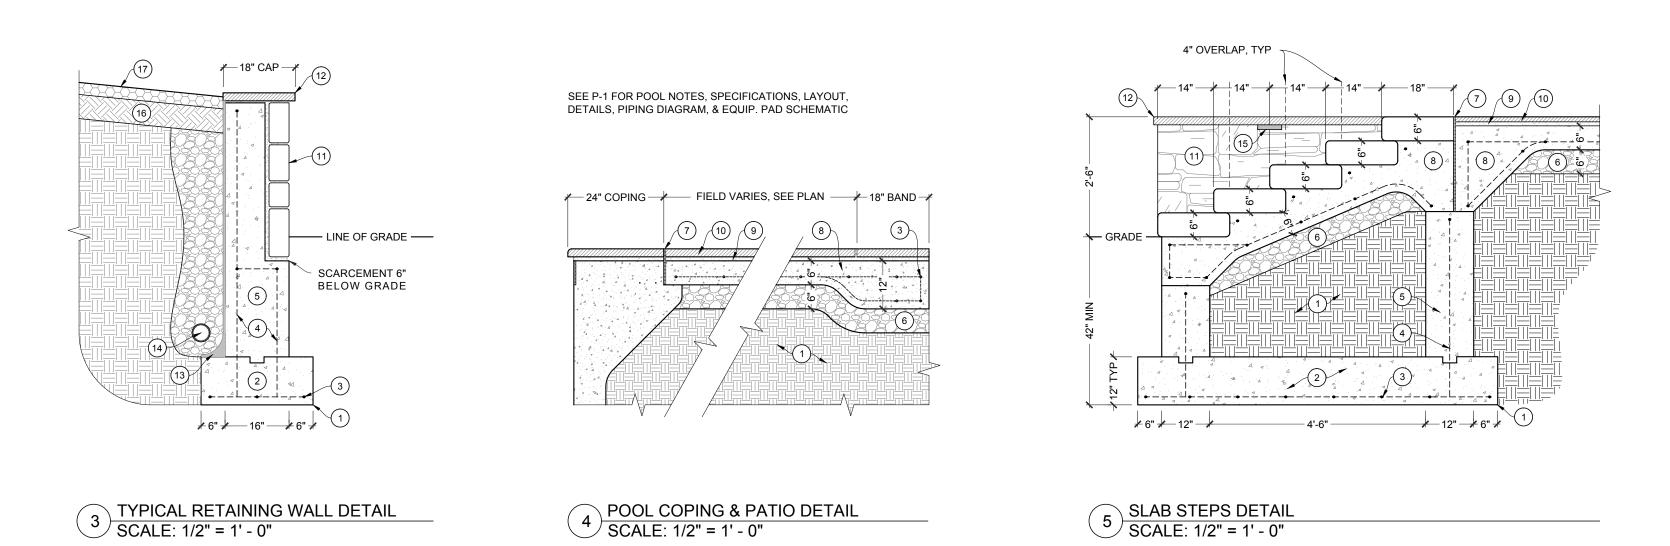



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ELEVATIONS, SECTIONS, & DETAILS

NO.	NO. Revisions or Type of Drawing Submittal	Date:
1	SW: Provided as Design Concept Drawing	11-04-2020
	SW: Design Development executed via Zoom meeting with Owners	12-07-2020
3	SW: Provided as Master Plan & bid drawings	12-07-2020
44	- SW: Provided as Working Drawings	02-13-2021
2		
9		
8		
6		

	Date:	November 3, 2020	
	Drawn By:	SW	
	Checked By:	N/A	
	Scale:	As Noted	
	North:	Sheet:	

